TREE INVENTORY

NOTES!

- ALL OFFSITE, EXISTING TREES SHALL BE PRESERVED.

- TREE SURVEY WAS COMPLETED BY: NORTHWESTERN ENGINEERING CONSULTANTS (PALATINE, IL - TEL 847.520.8410)
- TREE INVENTORY WAS COMPLETED BY: DICKSON DESIGN STUDIO, INC. (ALGONQUIN, IL - TEL 847.878.4019)

EXISTING TREES

Tag No.	Species	Common Name	Diameter	Condtion	Action
1	Salix var.	Weeping Willow	48"	Good	PRESERVE
2	Pinus nigra	Austrian Pine	12"	Fair	Remove
3	Rhamnus cathartica	Buckthorn	4"	Fair	Remove
4	Pinus nigra	Austrian Pine	10"	Fair	Remove
5	Pinus nigra	Austrian Pine	10"	Fair	Remove
6	Rhamnus cathartica	Buckthorn	4"	Fair	Remove
7	Pinus nigra	Austrian Pine	15"	Fair	Remove
8	Pinus nigra	Austrian Pine	10"	Fair	Remove
9	Pinus nigra	Austrian Pine	15"	Fair	Remove
10	Pinus nigra	Austrian Pine	15"	Fair	Remove
11	Pinus nigra	Austrian Pine	12"	Fair	Remove
12	Pinus nigra	Austrian Pine	15"	Fair	Remove
13	Pinus nigra	Austrian Pine	15"	Fair	Remove
14	Pinus nigra	Austrian Pine	12"	Fair	Remove
15	Pinus nigra	Austrian Pine	16"	DEAD	Remove - DEAD
16	Pinus nigra	Austrian Pine	15"	DEAD	Remove - DEAD
17	Pinus nigra	Austrian Pine	12"	Fair	Remove
18	Pinus nigra	Austrian Pine	15"	Fair	Remove
19	Pinus nigra	Austrian Pine	14"	Fair	Remove
20	Pinus nigra	Austrian Pine	12"	Fair	Remove
21	Pinus nigra	Austrian Pine	12"	Fair	Remove
22	Pinus nigra	Austrian Pine	15"	Fair	Remove
23	Pinus nigra	Austrian Pine	12"	Fair	Remove
24	Pinus nigra	Austrian Pine	12"	Fair	Remove
25	Pinus nigra	Austrian Pine	12"	Fair	Remove
26	Pinus nigra	Austrian Pine	15"	Fair	Remove
27	Pinus nigra	Austrian Pine	12"	Fair	Remove
28	Pinus nigra	Austrian Pine	12"	Fair	Remove
29	Pinus nigra	Austrian Pine	12"	Fair	Remove
30	Pinus nigra	Austrian Pine	15"	Fair	Remove
31	Pinus nigra	Austrian Pine	15"	Fair	Remove
32	Pinus nigra	Austrian Pine	15"	Fair	Remove
33	Gleditsia var.	Honeylocust	9"	Good	PRESERVE
34	Malus sp.	Crabapple	10' high	Good	PRESERVE
35	Gleditsia var.	Honeylocust	9"	Good	PRESERVE
36	Fraxinus var.	Ash	12"	DEAD	Remove - DEAD
37	Malus sp.	Crabapple	10' high	Good	Remove
38	Pinus nigra	Austrian Pine	8"	DEAD	Remove - DEAD
39	Malus sp.	Crabapple	10' high	Good	Remove
40	Fraxinus var.	Ash	12"	DEAD	Remove - DEAD
41	Fraxinus var.	Ash	10"	DEAD	Remove - DEAD
42	Fraxinus var.	Ash	10"	DEAD	Remove - DEAD
43	Fraxinus var.	Ash 	14"	DEAD	Remove - DEAD
44	Pinus var.	Pine	13"	Good	PRESERVE
45	Pinus var.	Pine	13"	Good	PRESERVE
46	Pinus var.	Pine	13"	Good	PRESERVE
47	Acer var.	Maple	10"	Good	PRESERVE
48	Pinus var.	Pine	12"	Good	PRESERVE
49	Pinus var.	Pine	12"	Good	PRESERVE


TOTAL QUANTITY OF TREES ONSITE: 49
TOTAL EXISTING, DEAD TREES - TO REMOVE: 8
TOTAL EXISTING, LIVE TREES - TO REMOVE: 31
TOTAL EXISTING TREES - TO PRESERVE: 10

NOTES

1. TREE PRESERVATION:

- A. ALL WORK MUST BE PERFORMED ACCORDING TO THE APPROVED TREE PRESERVATION PLAN. IT IS STRONGLY RECOMMENDED TO DOCUMENT GOOD STEWARDSHIP PRACTICES DURING CONSTRUCTION. IF REQUIRED, PRIOR TO COMMENCING ANY DEMOLITION / CONSTRUCTION ACTIVITY, NOTIFY MUNICIPAL FORESTRY DEPARTMENT (NOTIFY AT LEAST 48 HOURS IN ADVANCE OF WORK).
- B. AN APPROVED TREE PRESERVATION PLAN MUST BE AVAILABLE AT THE BUILDING SITE.
- C. PRIOR TO ANY DEMOLITION / CONSTRUCTION ACTIVITY, INSTALL TREE PRESERVATION FENCE AND PERFORM ROOT PRUNING FOR ALL PROTECTED TREES.
- D. FENCE THE CRITICAL ROOT ZONE (CRZ) / CANOPY DRIP-LINE, OF THE ENTIRE EXISTING TREE TO BE PRESERVED, WITH TREE PROTECTION FENCE. FENCE TO PREVENT WOUNDS TO THE TREE & SOIL COMPACTION. POST THE FENCE WITH A SIGN STATING, "TREE PROTECTION ZONE KEEP OUT".
- E. ALL REQUIRED TREE PROTECTION FENCING SHALL REMAIN IN PLACE UNTIL THE TIME OF FINISH GRADING AND LANDSCAPING.
- F. NO TRENCHING SHOULD BE DONE WITHIN THE TREE PROTECTION ZONES FOR ANY CONSTRUCTION ACTIVITY, UNLESS PRE-APPROVED BY PROJECT ARBORIST &/OR PROJECT LANDSCAPE ARCHITECT.
- G. NO GRADE CHANGES SHOULD BE DONE WITHIN THE TREE PROTECTION ZONES OF TREES FOR ANY CONSTRUCTION ACTIVITY.
- H. SHOULD IT BE NECESSARY TO TRENCH WITHIN THE CRZ FOR UTILITIES, INCLUDING DISCONNECTION OR CAPPING OF EXISTING UTILITIES, ALL TRENCHES SHALL BE HAND DUG. NO ROOTS LARGER THAN TWO INCHES (2") SHALL BE CUT, UNLESS NO OTHER ALTERNATIVE IS FEASIBLE. ALL SMALLER ROOTS THAT REQUIRE CUTTING, SHALL BE CUT WITH A SHARP PRUNING SAW. CUTS SHALL BE MADE FLUSH WITH THE SIDE OF THE TRENCH. IF AT ANY TIME, TWENTY-FIVE PERCENT (25%) OF THE AREA WITHIN THE CRZ IS BEING SEPARATED FROM THE TREE BY A TRENCH, THEN THE LINE SHALL BE EITHER RELOCATED OR INSTALLED USING TRENCH-LESS METHODS.
- I. LOCATE THE PROPOSED WATER AND SEWER LINES OUTSIDE OF THE TREE PROTECTION ZONE OR INSTALL THE SEWER AND WATER UTILITIES USING TRENCH-LESS METHODS. AUGER THROUGH THE ENTIRE TREE PROTECTION ZONE, LOCATE PITS OUTSIDE OF THE TREE PROTECTION ZONE.
- J. THE PROPOSED WATER SERVICE LINE VALVES (B-BOXES), ARE TO BE TEN FEET (10') FROM PRESERVED TREES. IF FUTURE UTILITY EXCAVATIONS NEED TO OCCUR, THIS REDUCES THE CHANCES OF EXTENSIVE STEM OR ROOT DAMAGE, WHICH COULD LEAD TO TREE DECLINE.
- K. AT NO TIME SHALL ANY EQUIPMENT, MATERIALS, SUPPLIES OR FILL SOIL BE ALLOWED IN THE TREE PROTECTION ZONE(S). DO NOT STORE EXCAVATED SOIL OR THE DUMPSTER WITHIN THE DRIP-LINE (CRZ) OF THE PRESERVED TREE(S).
- L. REMOVAL OF ANY HARDSCAPE WITHIN THE TREE PROTECTION ZONES WILL BE DONE BY HAND. NO ROOTS LARGER THAN TWO INCHES (2") SHALL BE CUT, UNLESS THERE IS NO ALTERNATIVE FEASIBLE. CUTS WILL BE MADE WITH A SHARP PRUNING SAW TO AVOID TEARING AND WILL BE FLUSH WITH THE TREE SIDE OF THE TRENCH.
- M. THE TREE PROTECTION ZONE MAY BE MULCHED TO IMPROVE THE GROWING CONDITIONS FOR TREE ROOTS AND TO MINIMIZE MAINTENANCE OF THE LAWN.
- N. ALL OFF-SITE TREES SHALL BE PRESERVED.
- O. EXISTING TREES SHOWN TO REMAIN SHALL BE PRESERVED TO THE BEST EXTENT POSSIBLE, PENDING FINAL SITE PLAN, FINAL CIVIL ENGINEERING, AND/OR ANY UNFORESEEN ISSUES.

TREE PROTECTION FENCE DETAIL

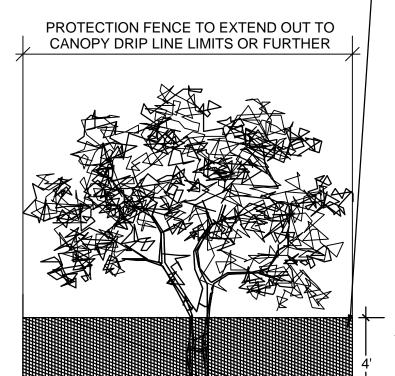

 FENCE TO BE PROVIDED AROUND ALL OFF-SITE TREES WHOSE CANOPY DRIP-LINE EXTENDS ACROSS BOUNDARIES OF PROJECT SITE.

FENCE IS FOR PROTECTION OF ZOOT ZONES.

FENCE SHALL REMAIN IN PLACE ON PROJECT SITE UNTIL ADJACENT CONSTRUCTION IS COMPLETE.

FENCE SHALL BE 4' TALL, ORANGE, SNOW-FENCE (OR APPROVED EQUAL), POSTED WITH A SIGN THAT READS: "TREE PROTECTION ZONE - KEEP OUT"

SECURE FENCE TO WOODEN STAKES OR METAL POLES, SPACED NO GREATER THAN 8' ON CENTER

AFTER EXISTING TREES ARE FENCED, NOTHING
IS TO BE DISTURBED, STORED, PARKED, ETC.,
INSIDE CONSTRUCTION FENCE. REMOVE
FENCE ONLY AFTER ALL CONSTRUCTION WORK
HAS BEEN COMPLETED.



526 SKYLINE DRIVE ALGONQUIN IL 60102 847 878 4019

CLIENT NAME AND ADDRESS

GARDEN COMMUNITIES

SHORT HILLS, NJ

PLAN DATE

OCTOBER 17, 2016

REVIS	IONS			
1.	PER	CIVIL	2/14	/17
2.	PER	SITE	PLAN	2/27/17
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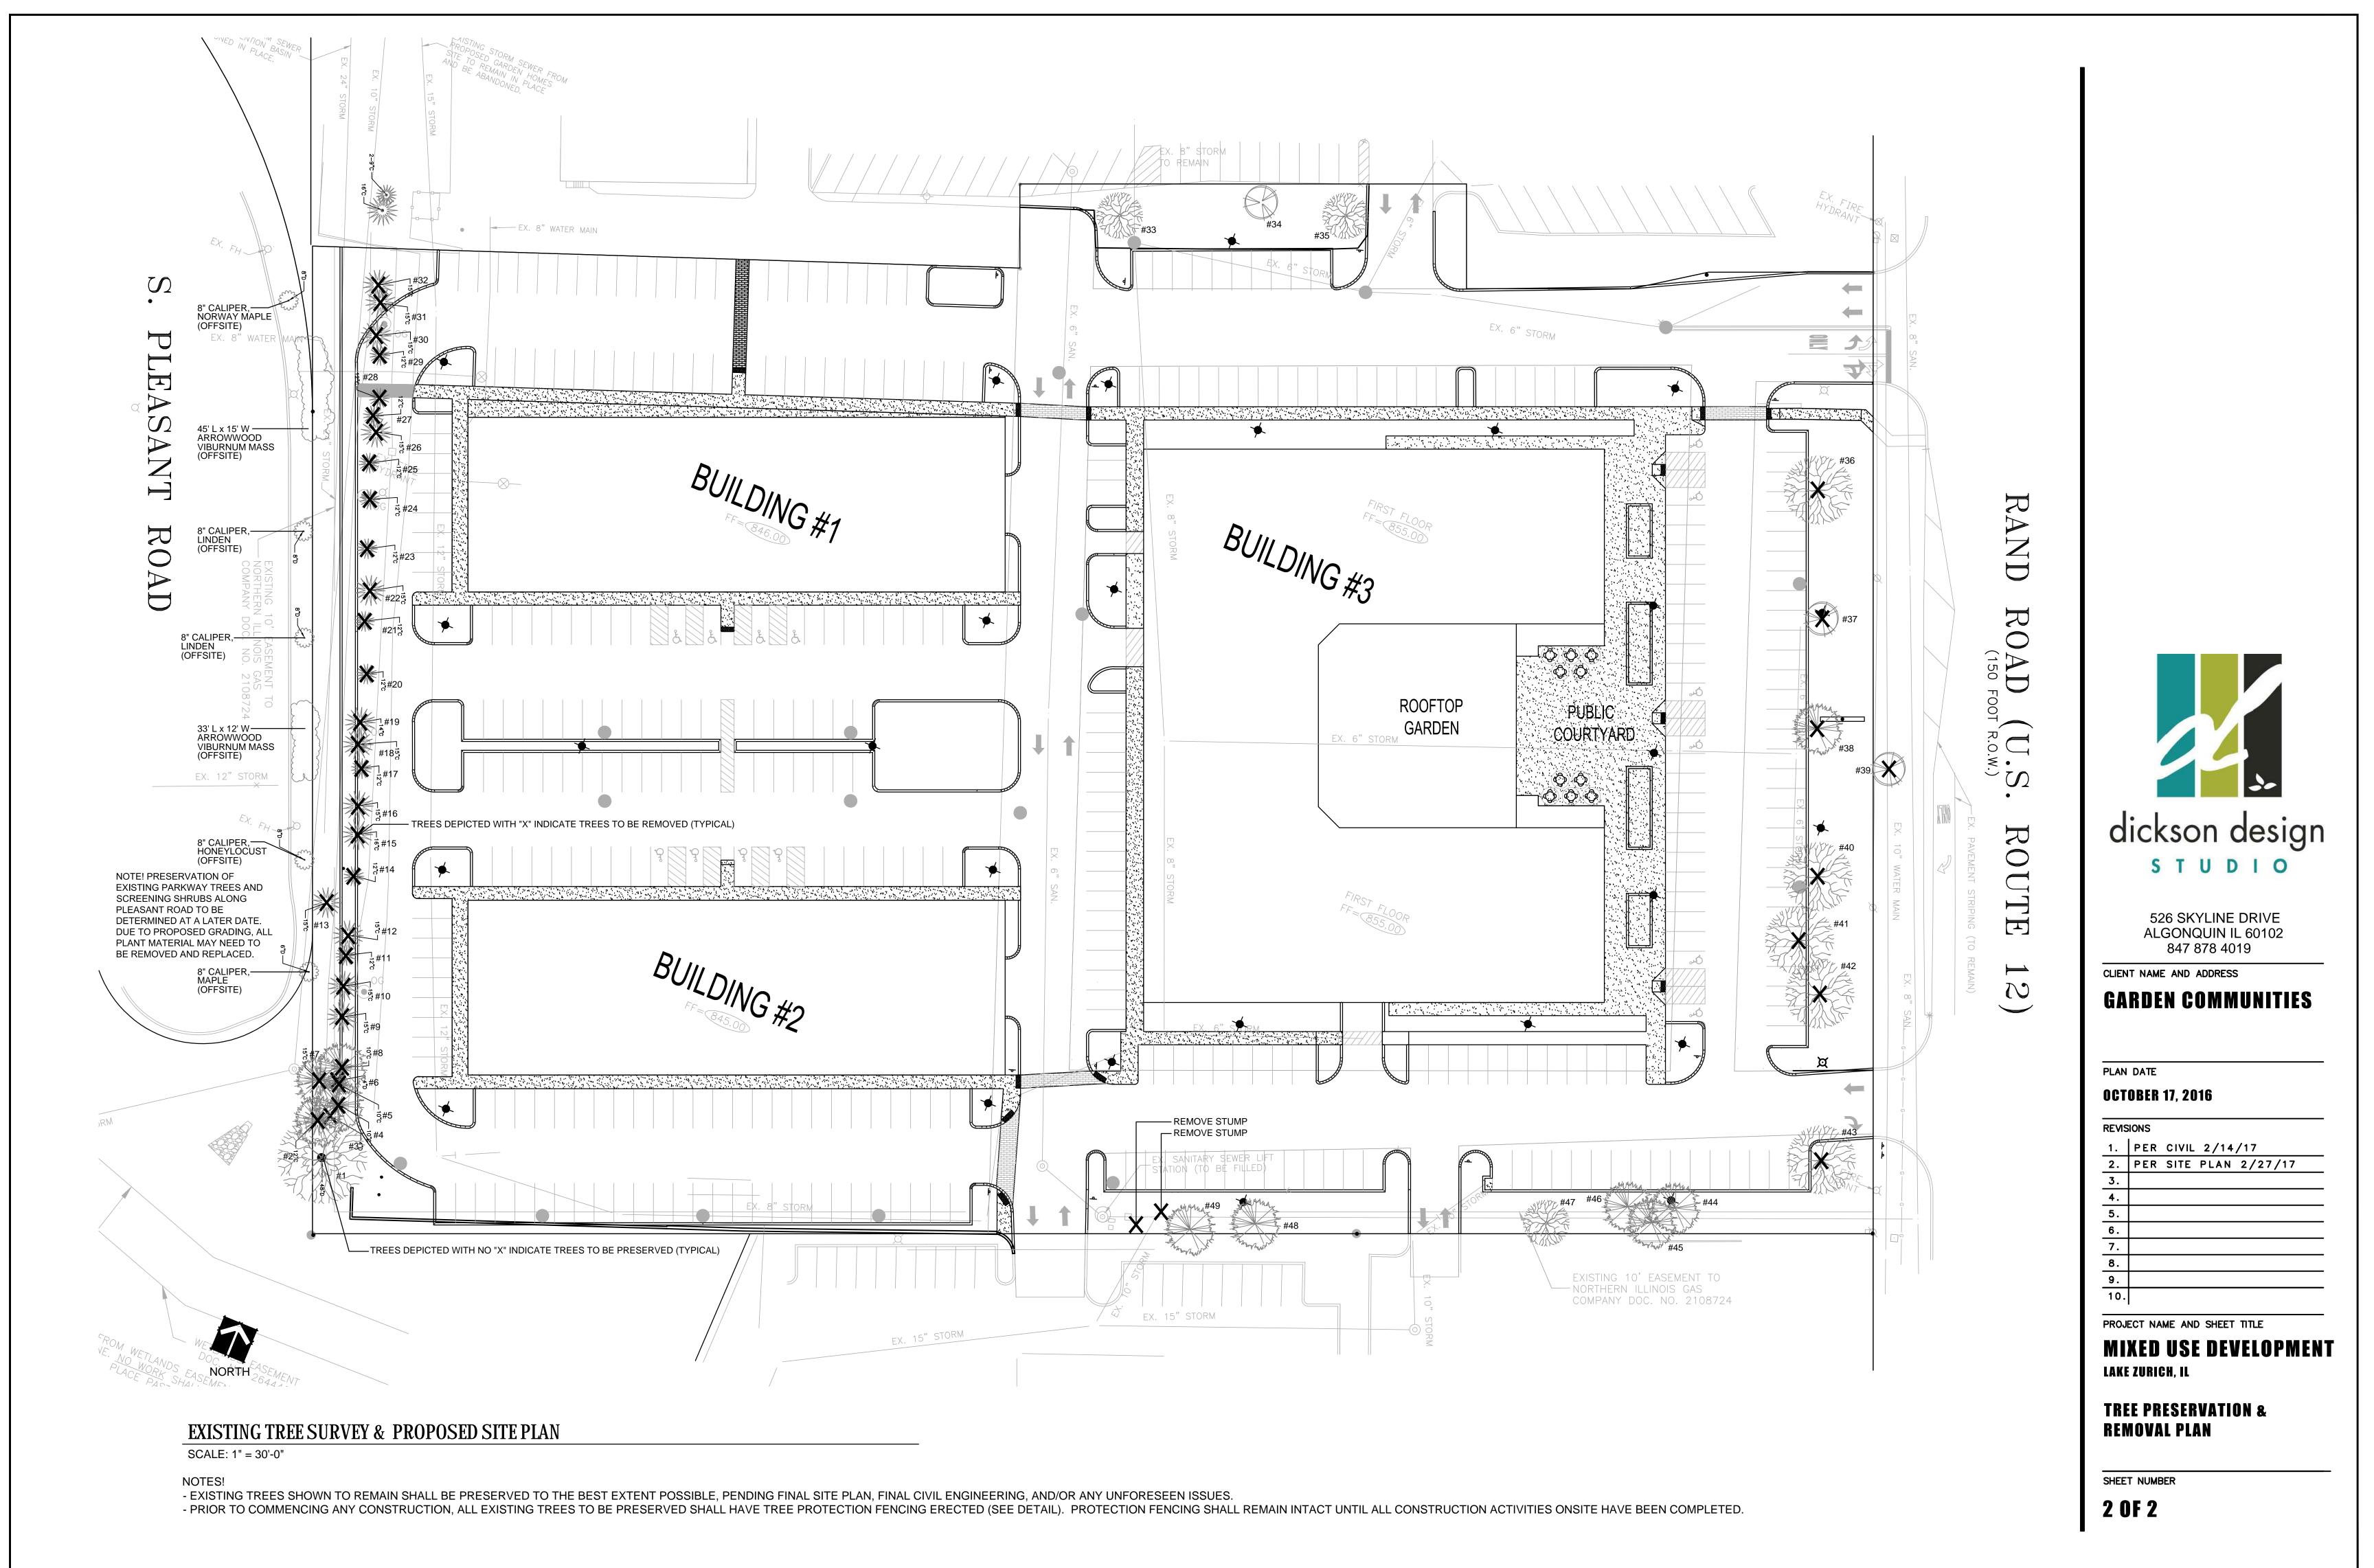
PROJECT NAME AND SHEET TITLE


MIXED USE DEVELOPMENT LAKE ZURICH, IL

TREE PRESERVATION & REMOVAL PLAN

SHEET NUMBER

1 OF 2



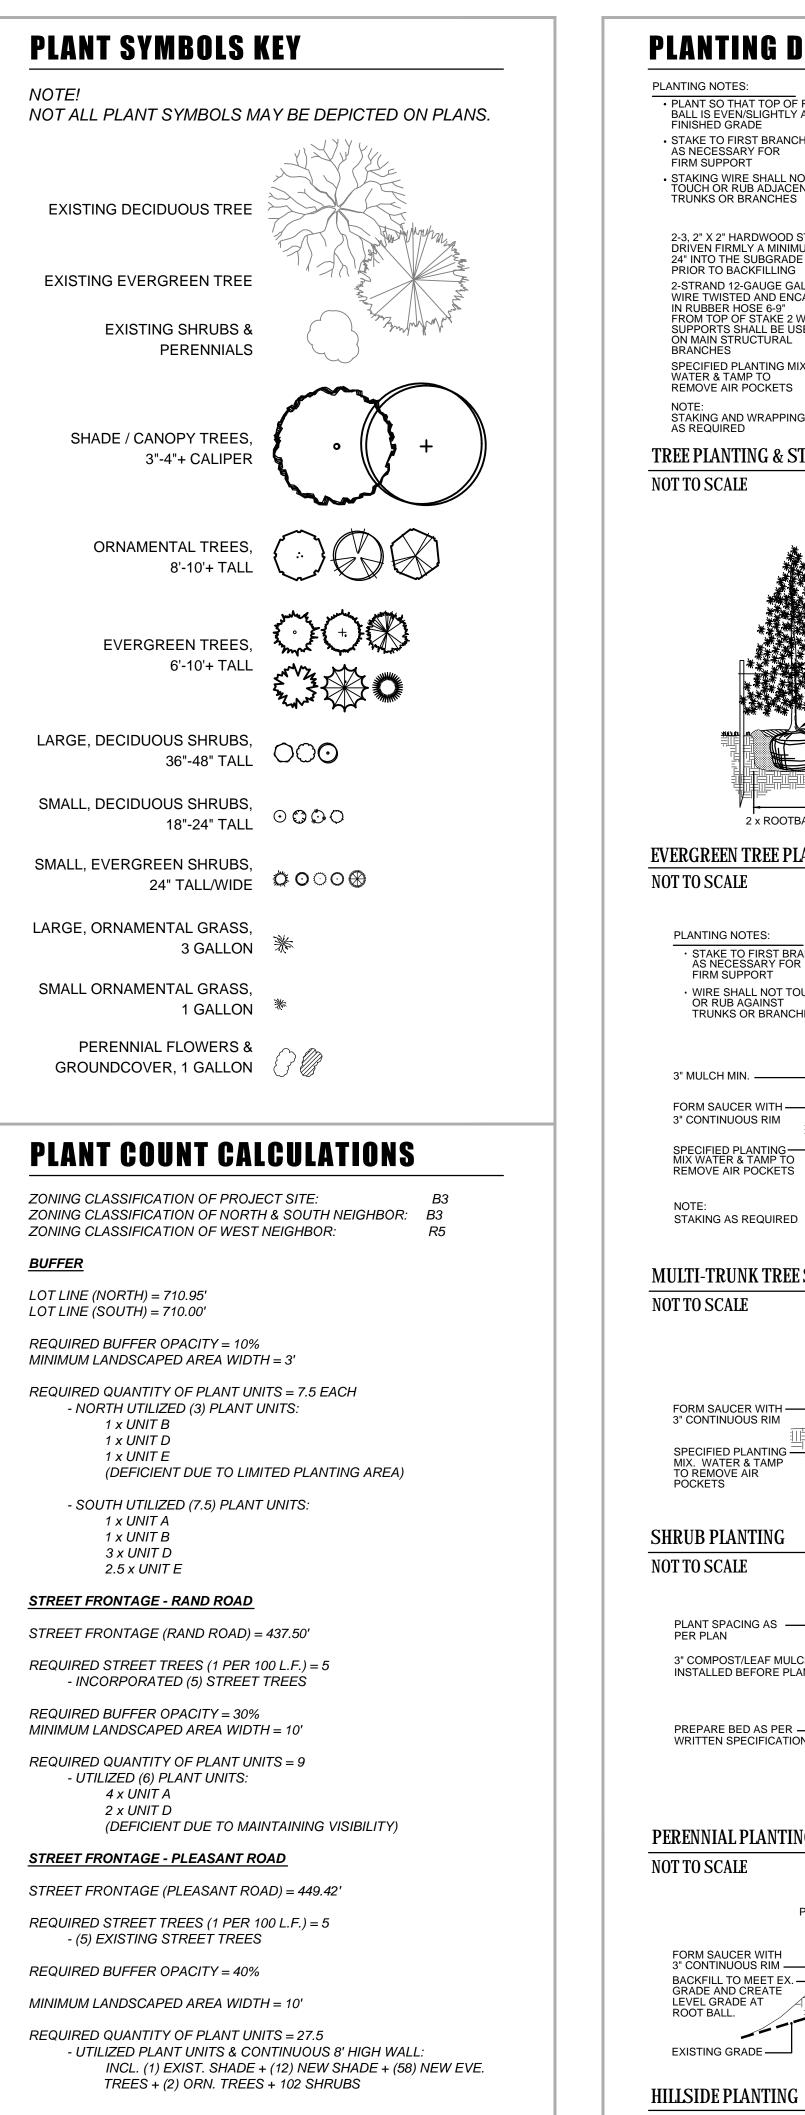

PLANTING DETAILS PLANTING NOTES: • PLANT SO THAT TOP OF ROOT BALL IS EVEN/SLIGHTLY ABOVE CANOPY SPREAD FINISHED GRADE • STAKE TO FIRST BRANCHES AS NECESSARY FOR FIRM SUPPORT STAKING WIRE SHALL NOT TOUCH OR RUB ADJACENT TRUNKS OR BRANCHES 2-3, 2" X 2" HARDWOOD STAKES -DRIVEN FIRMLY A MINIMUM OF PRIOR TO BACKFILLING 2-STRAND 12-GAUGE GALV.— -TREE WRAP WIRE TWISTED AND ENCASED IN RUBBER HOSE 6-9" -3" MULCH MIN. FORM SAUCER SUPPORTS SHALL BE USED ON MAIN STRUCTURAL BRANCHES SPECIFIED PLANTING MIX WATER & TAMP TO REMOVE AIR POCKETS STAKING AND WRAPPING TREE PLANTING & STAKING NOT TO SCALE PLANTING NOTES: STAKE AND GUY AS NEEDED • DO NOT CUT OR DAMAGE LEADER 2-STRAND 12-GAUGE GALV. WIRE TWISTED -AND ENCASED IN RUBBER HOSE 6 - 9" FROM TOP OF STAKE 12-GUAGE GALVANIZED WIRE, DOUBLE STRAND TWISTED. _SET ROOTBALL 3" HIGHER THAN GRADE AT WHICH TREE GREW ___ 4" DEEP WATER RETENTION BASIN - APPLY SPECIFIED MULCH 3" DEEP TO REMAIN PERMANENTLY FINISHED GRADE - 2" X 2" HARDWOOD STAKES DRIVEN FIRMLY A MINIMUM OF 24" INTO THE SUBGRADE PRIOR TO BACKFILLING - UNDISTURBED SUBGRADE 2 x ROOTBALL DIA EVERGREEN TREE PLANTING NOT TO SCALE PLANTING NOTES: STAKE TO FIRST BRANCHES AS NECESSARY FOR FIRM SUPPORT WIRE SHALL NOT TOUCH OR RUB AGAINST 2" X 2" HARDWOOD STAKES DRIVEN FIRMLY A MINIMUM OF 24" INTO THE SUBGRADE TRUNKS OR BRANCHES IN RUBBER HOSE 6 - 9" FROM TOP OF STAKE 3" MULCH MIN. -2 WIRE SUPPORTS SHALL BE USED ON MAIN STRUCTURAL FORM SAUCER WITH ----STAKING AS REQUIRED 2 X BALL DIA MULTI-TRUNK TREE STAKING NOT TO SCALE FORM SAUCER WITH -3" MULCH MIN. 3" CONTINUOUS RIM MIX. WATER & TAMP TO REMOVE AIR SHRUB PLANTING NOT TO SCALE PLANT SPACING AS -3" COMPOST/LEAF MULCH -INSTALLED BEFORE PLANTING PREPARE BED AS PER -WRITTEN SPECIFICATION PERENNIAL PLANTING NOT TO SCALE PLANT SO THAT TOP OF ROOTBALL IS EVEN WITH THE FINISHED — GRADE— 3" CONTINUOUS RIM -BACKFILL TO MEET EX. -LEVEL GRADE AT SPECIFIED PLANTING MIX. WATER & TAMP TO REMOVE AIR EXISTING GRADE -

NOT TO SCALE

GENERAL LANDSCAPE NOTES

- 1. CONTRACTOR SHALL OBTAIN ALL NECESSARY PERMITS REQUIRED. ALL CONSTRUCTION SHALL CONFORM TO APPLICABLE STANDARDS AND CODES.
- 2. CALL J.U.L.I.E. UTILITY LOCATING SERVICE (TEL 800.892.0123), 48 HOURS PRIOR TO THE START OF ANY DIGGING.
- 3. GENERAL PLANT NOTES:
 - A. ALL PLANT MATERIAL SHALL CONFORM IN SIZE AND GRADE IN ACCORDANCE WITH AMERICAN STANDARD FOR NURSERY STOCK.
 - B. ALL PLANT MATERIAL SHALL BE MAINTAINED ALIVE, HEALTHY, AND FREE FROM DISEASE AND PESTS.
 - C. ALL NEW PLANT MATERIAL SHALL BE FROM A LOCAL SOURCE WHENEVER POSSIBLE (LESS THAN 50 MILES).
 - D. PLANTS SHALL BE ALLOWED TO GROW IN THEIR NATURAL FORM / HABIT. PLANTS SHALL NOT BE PRUNED/HEDGED UNLESS ABSOLUTELY NECESSARY (DUE TO VISIBILITY OR HAZARD OBSTRUCTION).
 - E. ALL LANDSCAPED AREAS SHALL BE FREE OF WEEDS, LITTER, AND SIMILAR SIGNS OF DEFERRED MAINTENANCE.
 - F. MAINTENANCE AND CARE OF PLANT MATERIAL SHALL INCLUDE, BUT NOT BE LIMITED TO, WATERING, FERTILIZING (IF NECESSARY), DEAD-HEADING, WEEDING, AND MULCHING.
- 4. LOCATIONS OF PROPOSED PLANT MATERIAL MAY BE ADJUSTED AT TIME OF INSTALLATION DUE TO FINAL ENGINEERING AND FINAL LOCATION OF SITE UTILITIES.
- 5. THE LANDSCAPE CONTRACTOR IS RESPONSIBLE FOR PROVIDING AND SPREADING TOPSOIL (6"-12" DEEP), FINE GRADING, AND PREPARATION OF ALL LAWN AND LANDSCAPE AREAS. ALL SOILS SHALL BE FREE OF CONSTRUCTION DEBRIS, PRIOR TO INSTALLING ANY PLANT MATERIAL.
- 6. PRIOR TO SPREADING TOPSOIL, THE LANDSCAPE CONTRACTOR SHALL INSPECT AND ACCEPT ALL BASE GRADES. ANY DEVIATION FROM GRADES INDICATED ON THE GRADING PLAN SHALL BE CORRECTED BEFORE PLACING ANY TOPSOIL.
- 7. ALL SHRUB, GROUNDCOVER, PERENNIAL, AND ANNUAL PLANTING BEDS SHALL BE PREPARED WITH A SOIL AMENDMENT MIX - 1/3 TOPSOIL, 1/3 MUSHROOM COMPOST, AND 1/3 TORPEDO SAND. MATERIAL SHALL BE ROTO-TILLED JUST PRIOR TO THE INSTALLATION OF PLANT MATERIAL.
- 8. ALL PLANTING ISLANDS SHALL BE MOUNDED TO A CENTER HEIGHT OF TWELVE INCHES (12").
- 9. ALL PLANTING BEDS ADJACENT TO LAWN AREAS SHALL HAVE A SPADED EDGE BORDER, UNLESS METAL OR OTHER BORDER IS SPECIFIED.
- 10. ALL PLANTING BED AREAS SHALL MAINTAIN A MAX. 3" DEEP LAYER OF SHREDDED HARDWOOD MULCH (COLOR: NON-DYED, BROWN).
- 11. LANDSCAPE CONTRACTOR SHALL COORDINATE PLANTING SCHEDULE WITH LANDSCAPE MAINTENANCE CONTRACTOR. TO ENSURE PROPER WATERING OF PLANTED AND SODDED AREAS AFTER INITIAL INSTALLATION.
- 12. LANDSCAPE CONTRACTOR SHALL COORDINATE WORK WITH OTHER CONTRACTORS ON SITE TO MINIMIZE ANY REDO OF COMPLETED LANDSCAPE WORK AND DAMAGE TO PLANT MATERIAL.
- 13. CONTRACTOR SHALL BE RESPONSIBLE FOR HIS/HER OWN LAYOUT WORK. UPON REQUEST, LANDSCAPE ARCHITECT SHALL BE AVAILABLE TO ASSIST/APPROVE CONTRACTOR LAYOUT.
- 14. EVERY ATTEMPT HAS BEEN MADE TO DEPICT ALL EXISTING UTILITY LINES. CONTRACTOR SHALL USE PRECAUTION WHEN DIGGING. CONTRACTOR SHALL MAKE THEMSELVES THOROUGHLY FAMILIAR WITH ALL UNDERGROUND UTILITY LOCATIONS PRIOR TO ANY DIGGING, VERIFYING LOCATIONS AND DEPTHS OF ALL UTILITIES.
- 15. IT IS THE LANDSCAPE CONTRACTOR'S RESPONSIBILITY TO VISIT THE SITE PRIOR TO BID SUBMITTAL, TO BECOME FAMILIAR WITH EXISTING CONDITIONS AT THE SITE.
- 16. PLANT LIST QUANTITIES PROVIDED AT TIME OF FINAL PLANS ARE APPROXIMATIONS. CONTRACTORS ARE RESPONSIBLE FOR COMPLETING THEIR OWN QUANTITY TAKE-OFFS. IF A DISCREPANCY IS FOUND BETWEEN THE PLAN AND THE PLANT LIST, THEN THE PLAN SHALL PREVAIL.
- 17. PLANT SUBSTITUTIONS ARE ALLOWED DUE TO PLANT AVAILABILITY OR PLANTING TIME OF YEAR, ONLY WITH THE PRIOR CONSENT OF THE LANDSCAPE ARCHITECT. IF SUBSTITUTIONS ARE MADE WITHOUT PRIOR CONSENT, THE LANDSCAPE ARCHITECT MAINTAINS THE RIGHT TO REJECT MATERIAL IN THE FIELD, AT THE COST TO THE CONTRACTOR.
- 18. CONTRACTOR TO PROVIDE TEST OF EXISTING AND IMPORTED SOILS PER SPECIFICATIONS. PLANTING SOIL SHALL BE AMENDED PER SPECIFICATIONS.
- 19. CONTRACTOR SHALL NOTIFY LANDSCAPE ARCHITECT IF AREAS OF POOR DRAINAGE OR OTHER UNUSUAL SUBSURFACE CONDITIONS ARE ENCOUNTERED DURING EXCAVATION FOR PLANTING PITS.
- 20. ALL TURF SHALL SHALL BE KENTUCKY BLUEGRASS BLEND SOD (MINERAL, NOT PEAT), UNLESS OTHERWISE NOTED ON THE PLAN.
- 21. CONTRACTOR SHALL RESTORE LAWN AREAS THAT HAVE REMAINED PARTIALLY INTACT, TOP DRESSING WITH SOIL, SCARIFYING, AND SEEDING TO FORM A SMOOTH, FULL, EVEN LAWN, FREE OF BARE SPOTS, INDENTATIONS, AND WEEDS.
- 22. LANDSCAPE DETAILS SHOWN ARE FOR DESIGN INTENT ONLY, LANDSCAPE ARCHITECT ASSUMES NO LIABILITY. CONTRACTOR IS RESPONSIBLE FOR ERECTING AND INSTALLING PROPERLY BUILT AMENITIES PER CODE, PER SITE CONDITIONS (FINAL GRADING & UTILITY LOCATIONS), AND PER AREA CLIMATE CONDITIONS. ALL LANDSCAPE SITE DETAILS FOR STRUCTURES AND FOOTINGS SHALL BE REVIEWED & APPROVED BY A STRUCTURAL ENGINEER.
- 23. CONTRACTOR INSTALLATION BIDS SHALL INCLUDE A ONE-YEAR WARRANTY ON ALL PLANT MATERIAL, IN PERPETUITY.
- 24. (IF APPLICABLE) CONTRACTOR INSTALLATION BIDS SHALL INCLUDE A THREE-YEAR MONITORING AND MAINTENANCE PROGRAM ON ALL NATURALIZED DETENTION AREAS.

PROJECT TEAM

OWNER / DEVELOPER:

GARDEN HOMES 820 MORRIS TURNPIKE SHORT HILLS, NJ 07078 TEL (201) 788-9781

CONTACT: MARK HOFFMAN

CIVIL ENGINEER:

NORTHWESTERN ENGINEERING CONSULTANTS 675 N. NORTH COURT, SUITE 160 PALATINE, IL 60067 TEL (847) 520-8410

CONTACT: DAN HAVLIR

DESIGN ARCHITECT:

STUDIO CARNEY ARCHITECTURE INC. P.O. BOX 2291 PALATINE, IL 60078 TEL (847) 701-4138

CONTACT: MICHAEL CARNEY

ARCHITECT OF RECORD:

REITAN ARCHITECTS. LLC 1325 WILEY ROAD, SUITE 166 SCHAUMBURG, IL 60173 TEL (847) 519-1227

CONTACT: ED REITAN / MICHAEL CARNEY

LANDSCAPE ARCHITECT:

DICKSON DESIGN STUDIO, INC. 526 SKYLINE DRIVE ALGONQUIN, IL 60102 TEL (847) 878-4019

CONTACT: SHARON DICKSON

SHEET KEY

L0.1 PROJECT TEAM

GENERAL LANDSCAPE NOTES

PLANTING DETAILS

PLANT SYMBOLS KEY

PLANT COUNT CALCULATIONS

L1.1 LANDSCAPE PLAN



ALGONQUIN IL 60102 847 878 4019

526 SKYLINE DRIVE

CLIENT NAME AND ADDRESS

GARDEN COMMUNITIES

SHORT HILLS, NJ

PLAN DATE

OCTOBER 17, 2016

REVISIONS 1. | PER CIVIL 2/14/17 2. PER SITE PLAN 2/27/17 3.


PROJECT NAME AND SHEET TITLE

MIXED USE DEVELOPMENT LAKE ZURICH, IL

PRELIMINARY LANDSCAPE PLAN

SHEET NUMBER

10.

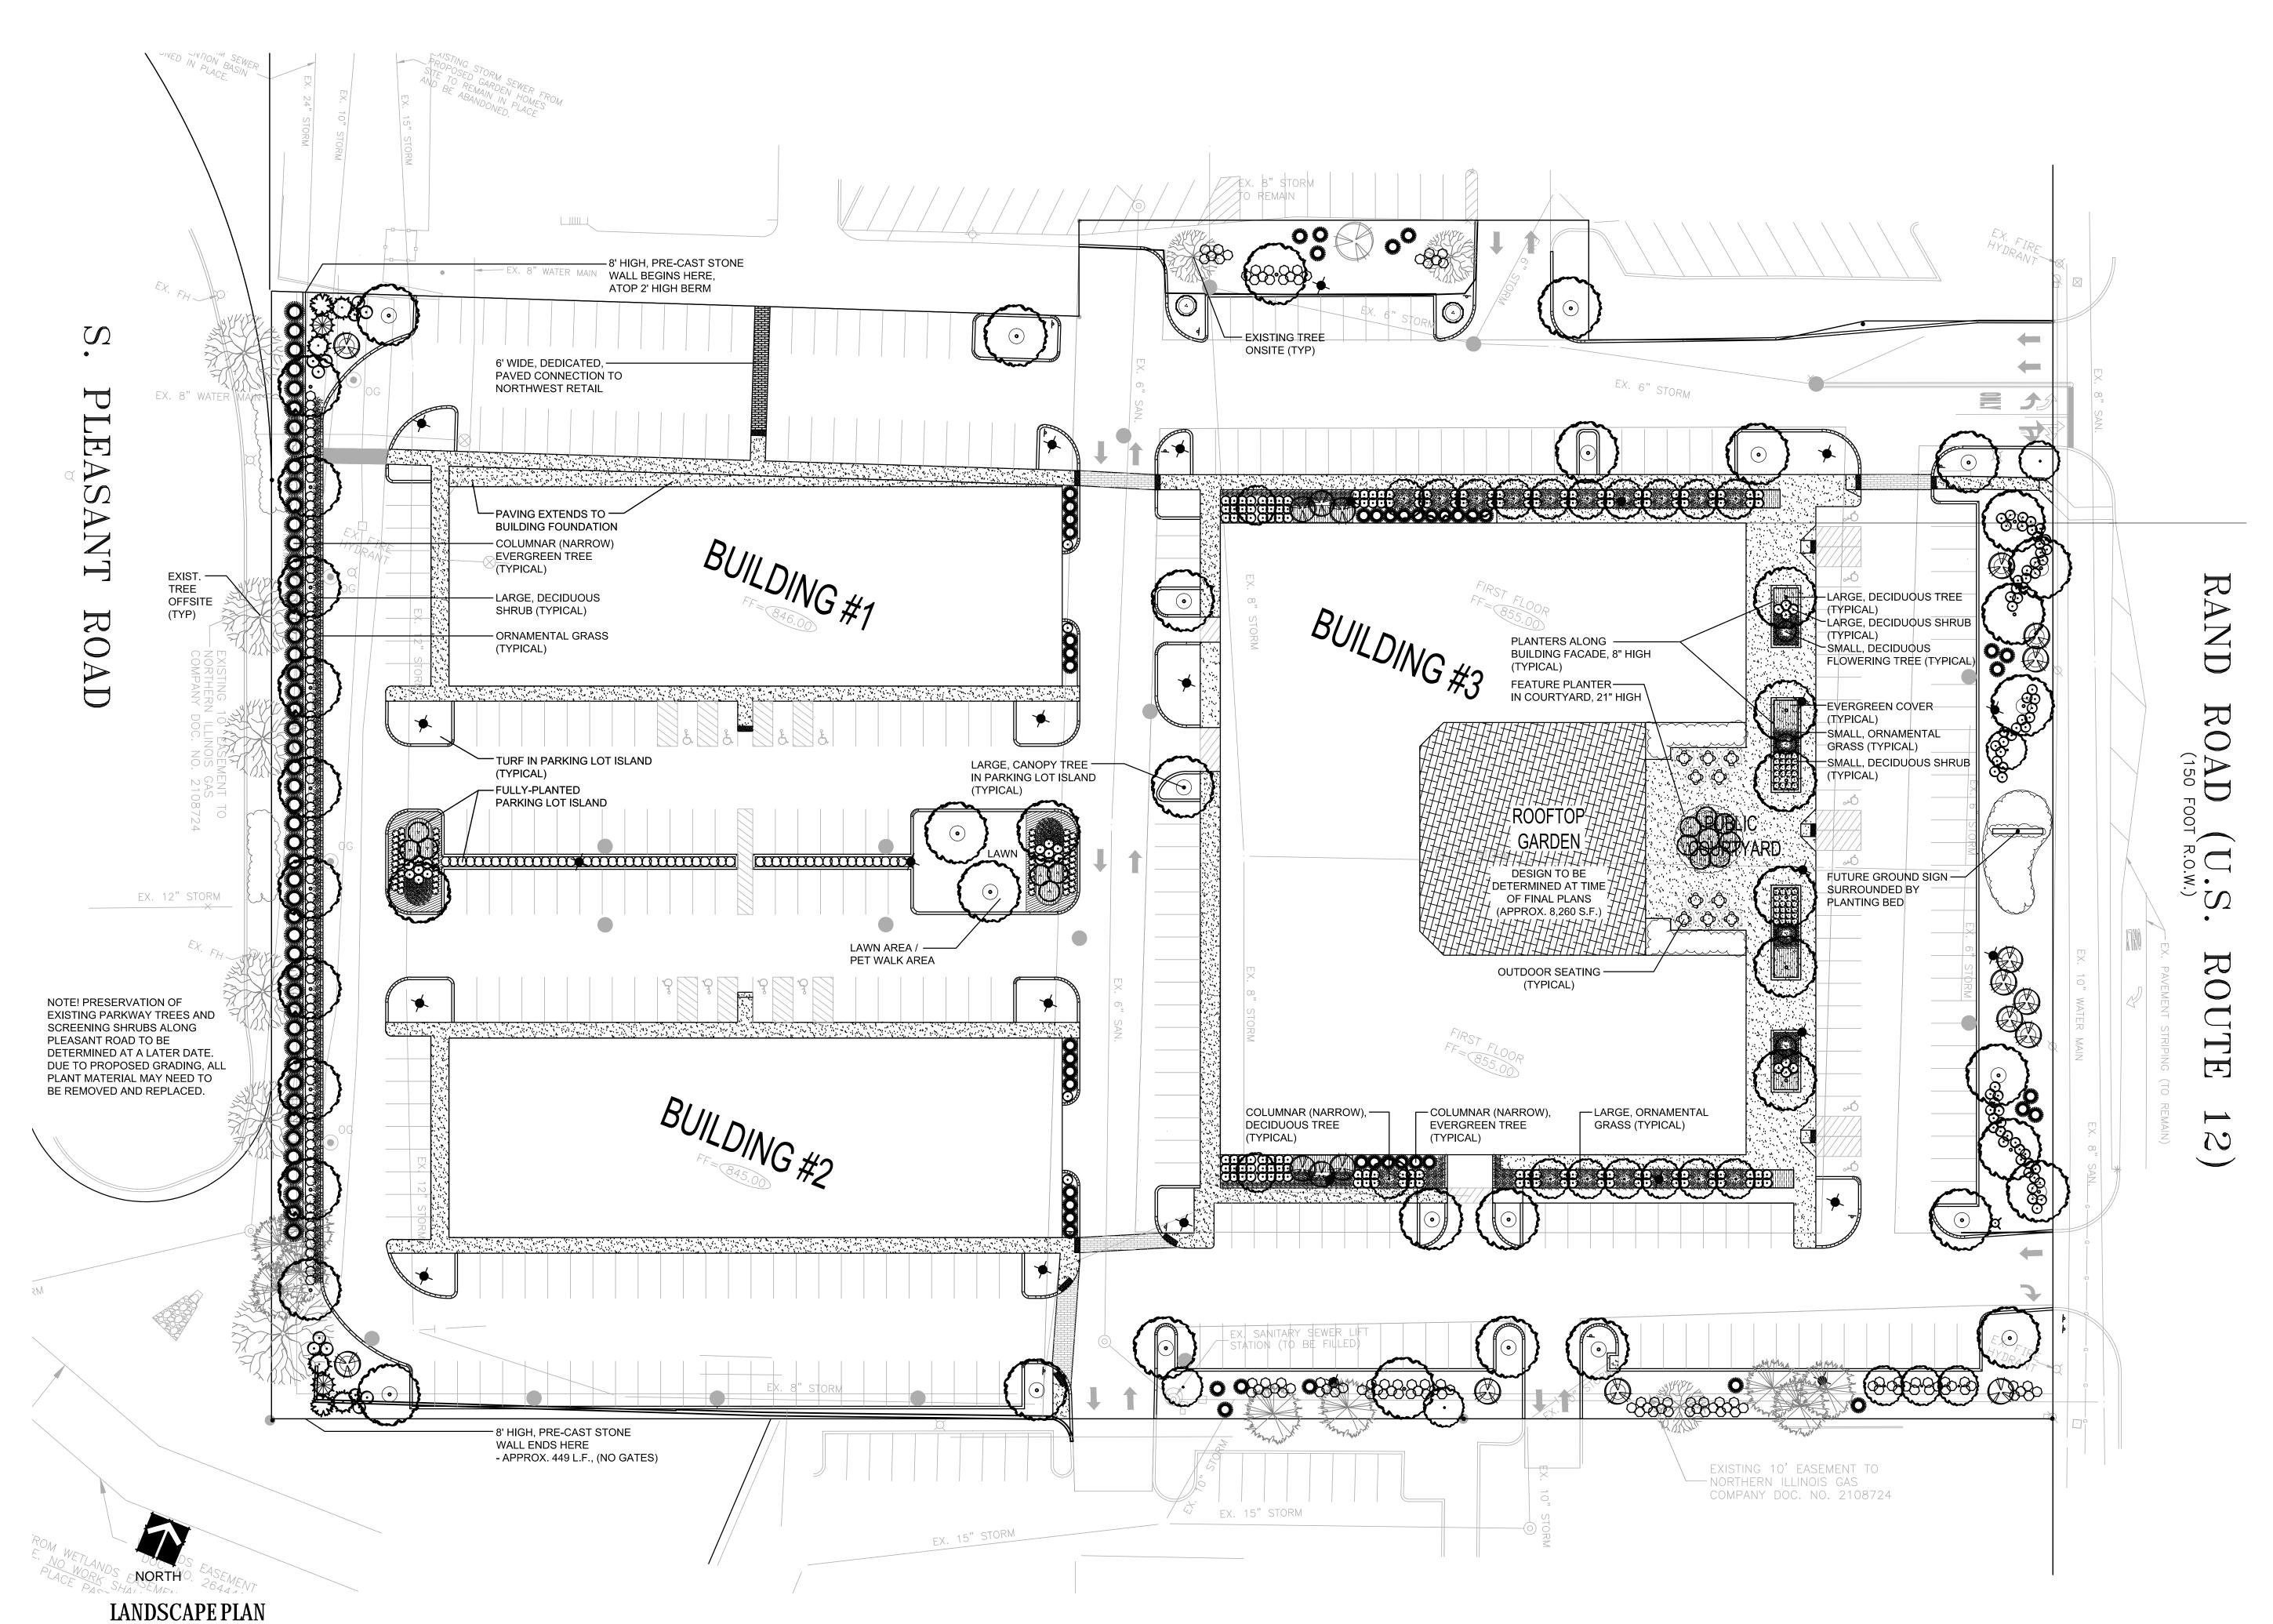

SCALE: 1" = 30'-0"



526 SKYLINE DRIVE ALGONQUIN IL 60102 847 878 4019

CLIENT NAME AND ADDRESS

GARDEN COMMUNITIES

SHORT HILLS, NJ

PLAN DATE

OCTOBER 17, 2016

REVISIONS

1. PER CIVIL 2/14/17
2. PER SITE PLAN 2/27/17
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PROJECT NAME AND SHEET TITLE

MIXED USE DEVELOPMENT LAKE ZURICH, IL

PRELIMINARY LANDSCAPE PLAN

SHEET NUMBER

L1.1